


**TREE INVENTORY LIST**

ID#	Tree Species (Latin)	Tree Species (Common)	D.B.H. (cm)	Drip Line (m)	Condition	Status	Ownership	Additional Notes
1	Acer platanoides	Norway Maple	55	6	Fair-good	To be preserved	Subject Site	Dead branches, debris stacked at base.
2	Galts occidentalis	Hackberry	55	6	Fair	To be preserved	Subject Site	Wounding, dead limbs.
3	Prunus serotina	Black Cherry	31	8	Fair	To be removed	Subject Site	4 stems, included bark.
4	Picea glauca	White Spruce	27	4	Fair	To be removed	Subject Site	
5	Acer rubrum	Red Maple	15	3	Excellent	To be preserved	On adjacent property	
6	Juglans nigra	Walnut	90	8	Good-Excellent	To be preserved	On adjacent property	Coppice
7	Juglans nigra	Walnut	100	9	Good	To be preserved	On adjacent property	
8	Acer platanoides	Red Norway Maple	34	4	Fair	To be preserved	On adjacent property	Major structural issues.
9	Picea pungens	Blue Spruce	35	4	Good	To be preserved	On adjacent property	
10	Picea pungens	Blue Spruce	15	3	Good	To be preserved	On adjacent property	Suppressed.
11	Picea glauca	White Spruce	15	3	Good	To be preserved	On adjacent property	Suppressed.
12	Betula papyrifera	White Birch	15	4	Good	To be preserved	On adjacent property	Multi-stemmed.
13A	Acer platanoides	Norway Maple	10	3	Fair	To be preserved	Subject Site	Lean.
14	Acer platanoides	Norway Maple	22	6	Fair-good	To be preserved	In ROW	Lean/pruned.
15	Galts occidentalis	Hackberry	43	6		To be preserved	Subject Site	Major structural issues

**LEGEND**

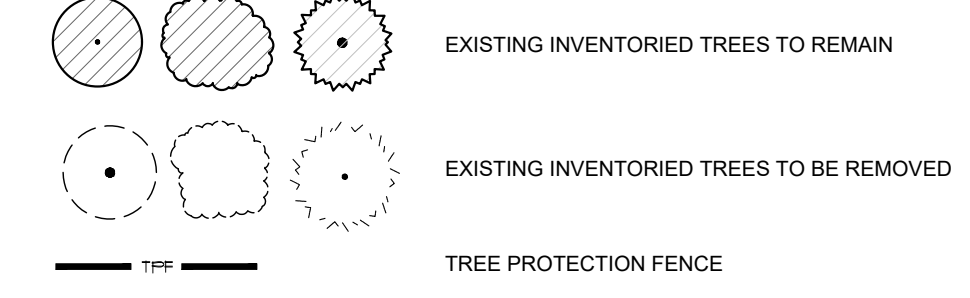


**NOTES:**  
 SITE VISIT DATE: JUNE 17, 2024.  
 TREE INVENTORY COMPLETED BY ISA CERTIFIED ARBORIST AARON HILL #ON-3088A  
 TREE LOCATIONS AND DRIPLINES BASED ON EXISTING CONDITIONS PROVIDED BY GRIT ENGINEERING TOPOGRAPHIC SURVEY.  
 TREES WITH "A" SUFFIX ARE APPROXIMATE, BASED ON AERIAL PHOTOGRAPHY AND HILL DESIGN STUDIO SITE REVIEW.  
 ALL VEGETATION 10cm D.B.H. AND GREATER ON SITE AND WITHIN 6m OF PROPERTY BOUNDARY HAVE BEEN IDENTIFIED.

A NOTICE OF IMPACT TO BE PROVIDED TO ADJACENT PROPERTY OWNERS WHOSES TREES MAY BE IMPACTED/INJURED DUE TO CONSTRUCTION ACTIVITIES (TREES #8 AND #9)

**COMPENSATION PLANT MATERIAL LIST**


KEY	QUANT.	BOTANICAL NAME	COMMON NAME	SIZE	COND.
AS	2	Acer saccharum Autumn Fest	Autumn Fest Sugar Maple	60mm cal.	W.B.

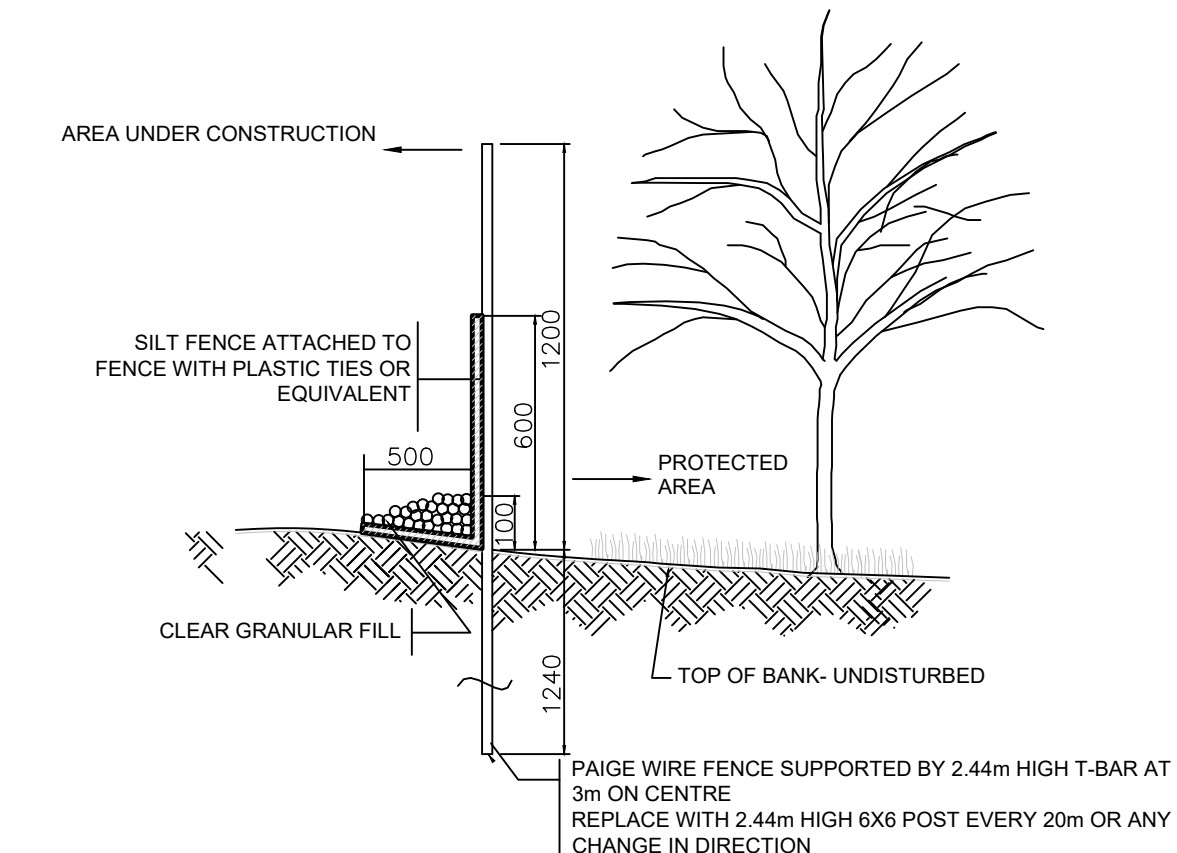

1 TREE PROTECTION FENCING DETAIL  
 NTS


**TREE PROTECTION NOTES**

- PRIOR TO THE REMOVAL OF VEGETATION ON SITE AND/OR THE START OF CONSTRUCTION, A CERTIFICATION LETTER VERIFYING TREE PROTECTION FENCING HAS BEEN INSTALLED IS TO BE SUBMITTED TO THE ENGINEERING SERVICES LANDSCAPE REPRESENTATIVE IN COMPLIANCE WITH THE APPROVED PLANS.
- AS PART OF ANY TREE REMOVAL OPERATION ALL STEMS, LIMBS AND STUMPS SHOULD BE REMOVED FROM THE SITE.
- UPON COMPLETION OF ANY TREE REMOVAL OPERATIONS, TREE PROTECTION FENCING SHOULD BE INSTALLED AS ILLUSTRATED. TREE PROTECTION FENCING WILL REMAIN INSTALLED DURING THE DURATION OF CONSTRUCTION.
- ANY ROOTS DISTURBED DURING CONSTRUCTION SHOULD BE CUT CLEANLY AND BURIED IMMEDIATELY.
- NO HEAVY EQUIPMENT OR STOCKING OF MATERIAL SHALL OCCUR WITHIN THE DRIPLINES OF ANY TREES THAT ARE TO BE PRESERVED.
- TREE PROTECTION MEASURES TO BE INSPECTED BY LANDSCAPE ARCHITECT AND CITY STAFF PRIOR TO START OF CONSTRUCTION.
- IF CONSTRUCTION OR ANY WORK OCCURS WITHIN THE TREE PRESERVATION ZONE, INSIDE THE LIMITS OF THE TREE PROTECTION FENCE, IT IS NECESSARY TO ONLY USE HAND TOOLS. NO MACHINERY WILL BE PERMITTED IN THIS ZONE. ANY WORK WITHIN THE TPZ MUST BE APPROVED BY LANDSCAPE ARCHITECT.
- ANY TREES PROPOSED TO BE PROTECTED ARE IMPACTED BY DEVELOPMENT WILL BE REPLACED WITH THE SAME SPECIES OF AN APPROVED ALTERNATE.
- NO VEGETATION REMOVALS ARE TO OCCUR ON THE SITE UNTIL THE TIME OF FINAL SITE PLAN APPROVAL.

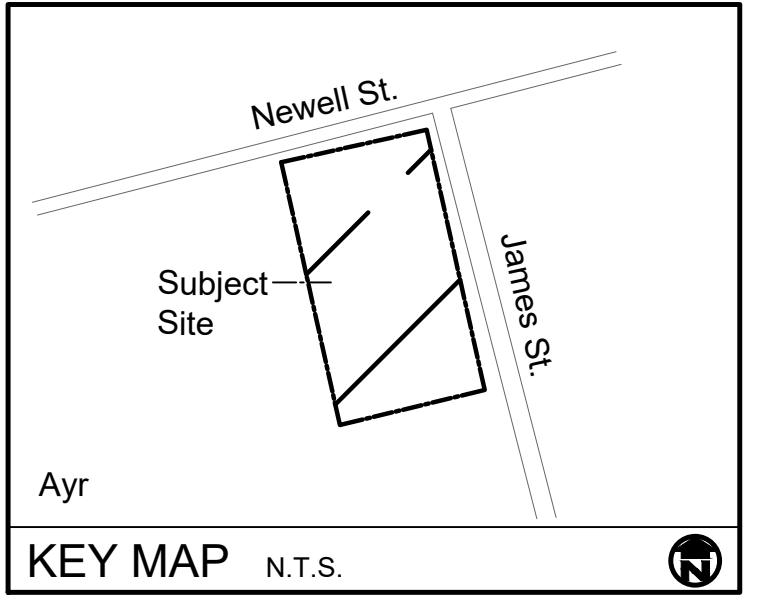

**GENERAL NOTES**

- ALL WORKMANSHIP WILL BE TO THE STANDARDS OF LANDSCAPE ONTARIO.
- CONTRACTOR TO LOCATE ALL UNDERGROUND UTILITIES.
- SITE PLAN INFORMATION AS PER DRYDEN SMITH & HEAD.
- EXISTING CONDITIONS PROVIDED BY GRIT ENGINEERING.

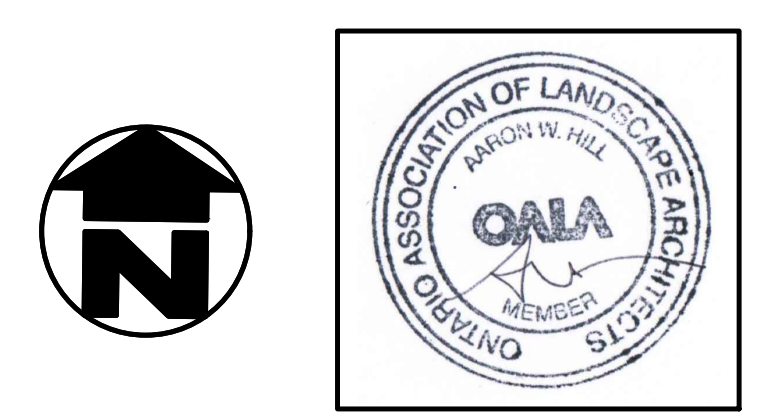

**REVISIONS**

No.	Date	Description	By
1	Jun 25 24	Issued for approval	AWH
2	Aug 23 24	As per revised engineering	AWH

37 Newell St.  
 Ayr, Ontario  
**Tree Management Plan**



PROJECT NO: 2024-37 DRAWN BY: MJH  
 SCALE: 1:125 DESIGNED BY: AWH  
 SHEET: APPROVED BY: AWH  
**L1** PLOT DATE: 08/23/2024